

PROJECT NAME: PRP_VZW_VCA2_OR Beaverton

PROJECT ADDRESS: 13855 SW BARROWS RD, BEAVERTON, OR 97223

PROJECT TYPE: EXISTING PGE WOOD POLE COLLOCATION

CUSTOMER NODE ID #: 5000344152

CROWN NODE ID #: CITATION 7

POLE ID #: C1133C-3549

HUB NAME: 167612

CARRIER: VERIZON

COORDINATES: LAT: 45.437909° LONG: -122.819347°

CROWN CASTLE BILLING / SCU #: 525572

JURISDICTION

BEAVERTON CITY
12725 SW MILKMAN WAY
BEAVERTON, OR 97005
PH: 503-526-2403

HANDICAPPED REQUIREMENTS

FACILITY IS UNMANNED AND NOT FOR HUMAN HABITATION. HANDICAPPED ACCESS REQUIREMENTS ARE NOT REQUIRED.

PARCEL INFORMATION

TBD

POLE OWNER

541-232-2530

IRVINE, CA 92618

CONTACT: LANISHA KELLY

PHONE #: 323-855-4967

PORTLAND GENERAL ELECTRIC

SCOTT ZISKA

SCOTT.ZIKSA@PGN.COM

EMAIL: LANISHA.KELLY@CROWNCASTLE.COM

COMPANY: P. MARSHALL & ASSOCIATES

CONTACT: PAT MARSHALL

COMPANY: CROWN CASTLE

CONTACT: AMANDA NATIONS

COMPANY: CROWN CASTLE

PHONE #: 206-336-2889

SEATTLE, WA 98109

PHONE #: 678-280-2325

PERMITTING

UTILITIES:

SURVEY:

ADDRESS: 6801 PORTWEST DR, STE 100

HOUSTON, TX 77024

ADDRESS: 1505 WESTLAKE AVE. N., STE 800

PAT.MARSHALL@PMASS.COM

EMAIL: AMANDA.NATIONS@CROWNCASTLE.COM

ADDRESS: 200 SPECTRUM CENTER DR., STE 1900

COMPANY: S&F LAND SERVICES, LLC ADDRESS: 901 NW CARLTON, STE 3 BEND, OR 97703

CONTACT: MATT FAULKNER
EMAIL: MATT.FAULKNER@SFLANDS.COM

PROJECT SUMMARY

CROWN CASTLE 1505 WESTLAKE AVE. N., STE 800 SEATTLE, WA 98109

CODES:

APPLICANT:

GENERAL ORDER (GO) 95, RULE 94 2018 INTERNATIONAL BUILDING CODE (IBC) 2020 NATIONAL ELECTRICAL CODE (NEC)

PLUMBING REQUIREMENTS

FACILITY HAS NO PLUMBING

POWER COMPANY

PORTLAND GENERAL ELECTRIC

NOTE: THE PROPOSED POLE DESIGN
CONTAINED IN THIS DRAWING PACKAGE IS
CURRENTLY OUT OF COMPLIANCE WITH
TIGARD CODE WHICH STATES THAT POLES
SUPPORTING STREETLIGHTS SHALL NOT BE
USED AND THAT ALL PROPOSED
EQUIPMENT TO BE INTEGRATED WITHIN
THE POLE. A VARIANCE REQUEST OR
ALTERNATIVE DESIGN IS CURRENTLY TO BE
DETERMINED.

PROJECT DESCRIPTION

THIS PROJECT CONSISTS OF THE INSTALLATION OF PROPOSED SMALL CELL EQUIPMENT AND ASSOCIATED ELECTRICAL COMPONENTS ALONG WITH NECESSARY MOUNTING HARDWARE ON AN EXISTING OWNED BY PORTLAND GENERAL ELECTRIC. PROPOSED POWER AND FIBER WILL BE DELIVERED OVERHEAD.

- (3) ERICSSON AIR 1652 B77D ANTENNA/RADIO UNITS
- (1) JMA WIRELESS CX200MI236-3Cxy OMNIDIRECTIONAL ANTENNA (1) ERICSSON - RADIO 4455 RADIO UNIT
- (1) 2" POWER SERVICE RISER CONDUIT
- (1) SQUARE D QO612L100RB AC LOAD CENTER/DISCONNECT SWITCH
- CIRCUITS AND FEEDERS FOR EQUIPMENT

THE PLANS AND DETAILS IN THIS DRAWING SET REPRESENT A PORTION OF A SMALL CELL NETWORK TO BE CONSTRUCTED IN PUBLIC RIGHT OF WAY PURSUANT TO AUTHORITY GRANTED BY BEAVERTON CITY. THIS PROJECT MEETS BEAVERTON CITY DESIGN MANUAL STANDARDS AND GUIDELINES. PROPOSED POWER TO BE BROUGHT TO AC DISCONNECT ON POLE.

PGE TO OBTAIN PERMITS FOR POLE REPLACEMENT UNDER SEPARATE APPLICATION. NO SMALL CELL WIRELESS EQUIPMENT SHALL BE INSTALLED UNTIL

NODE LOCATION MAP

AFTER PGE POLE REPLACEMENT IS COMPLETE







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REVISION REV DATE DRWN DESCRIPTION DES./Q A 10/11/2023 MAG PRELIMINARY DC B 01/10/2024 TD PRELIMINARY DC C 02/13/2024 MAG PRELIMINARY DC D 02/29/2024 TD PRELIMINARY DC E 06/11/2024 MAG LOWERED 5G ANT.





13855 SW BARROWS RD BEAVERTON, OR 97223


HUB: 167612

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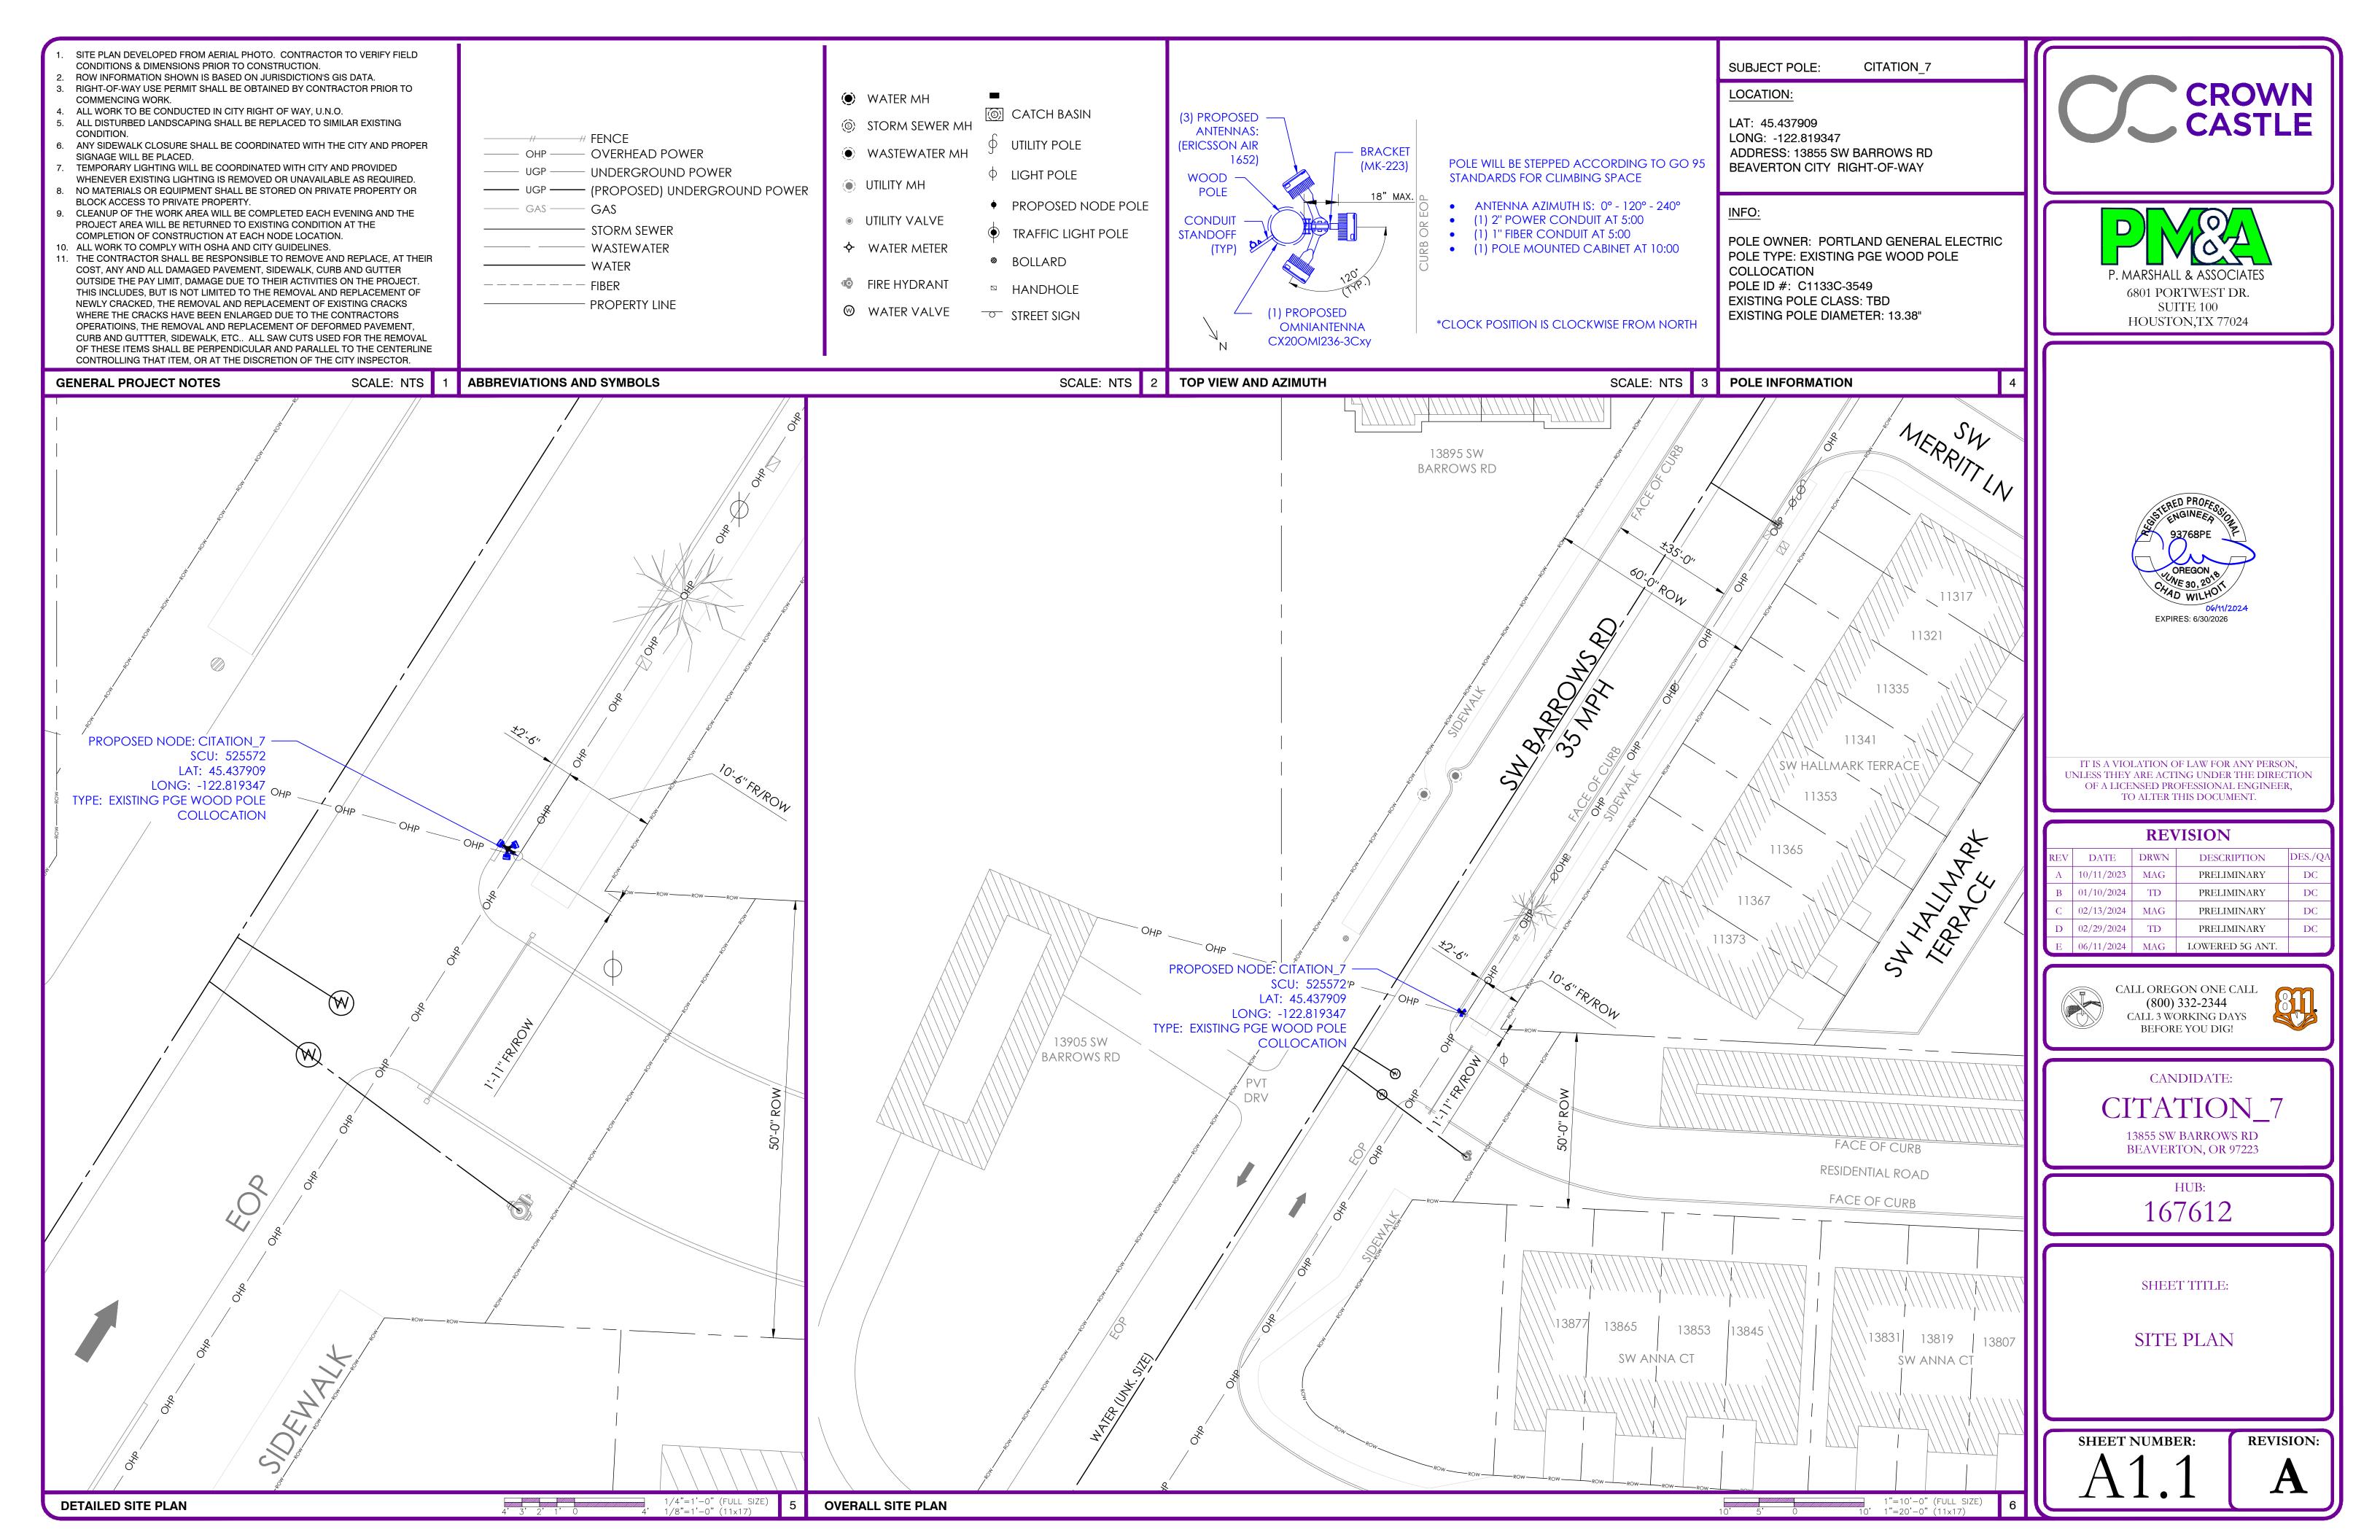
TITLE SHEET


SHEET NUMBER:

BER: REVISION:

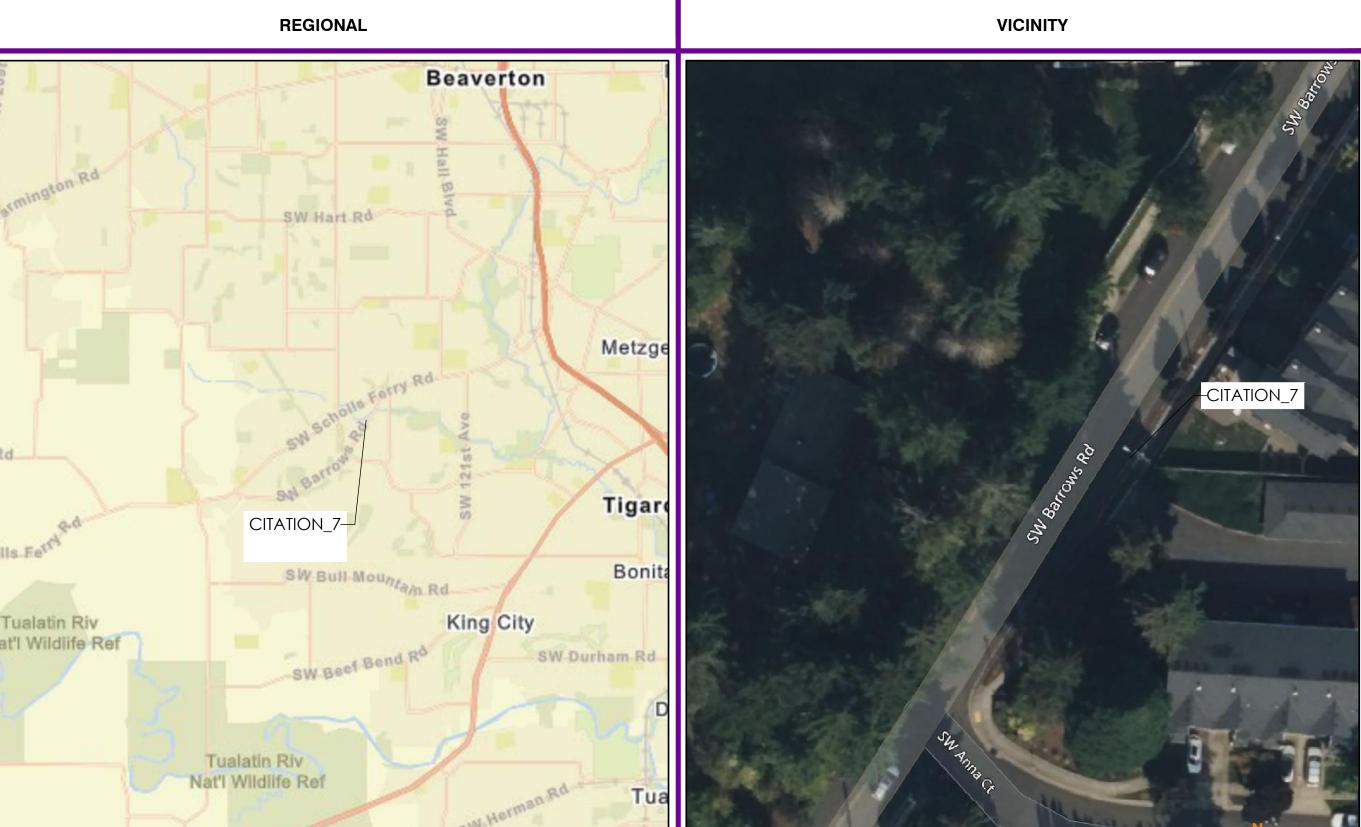

Nasoma



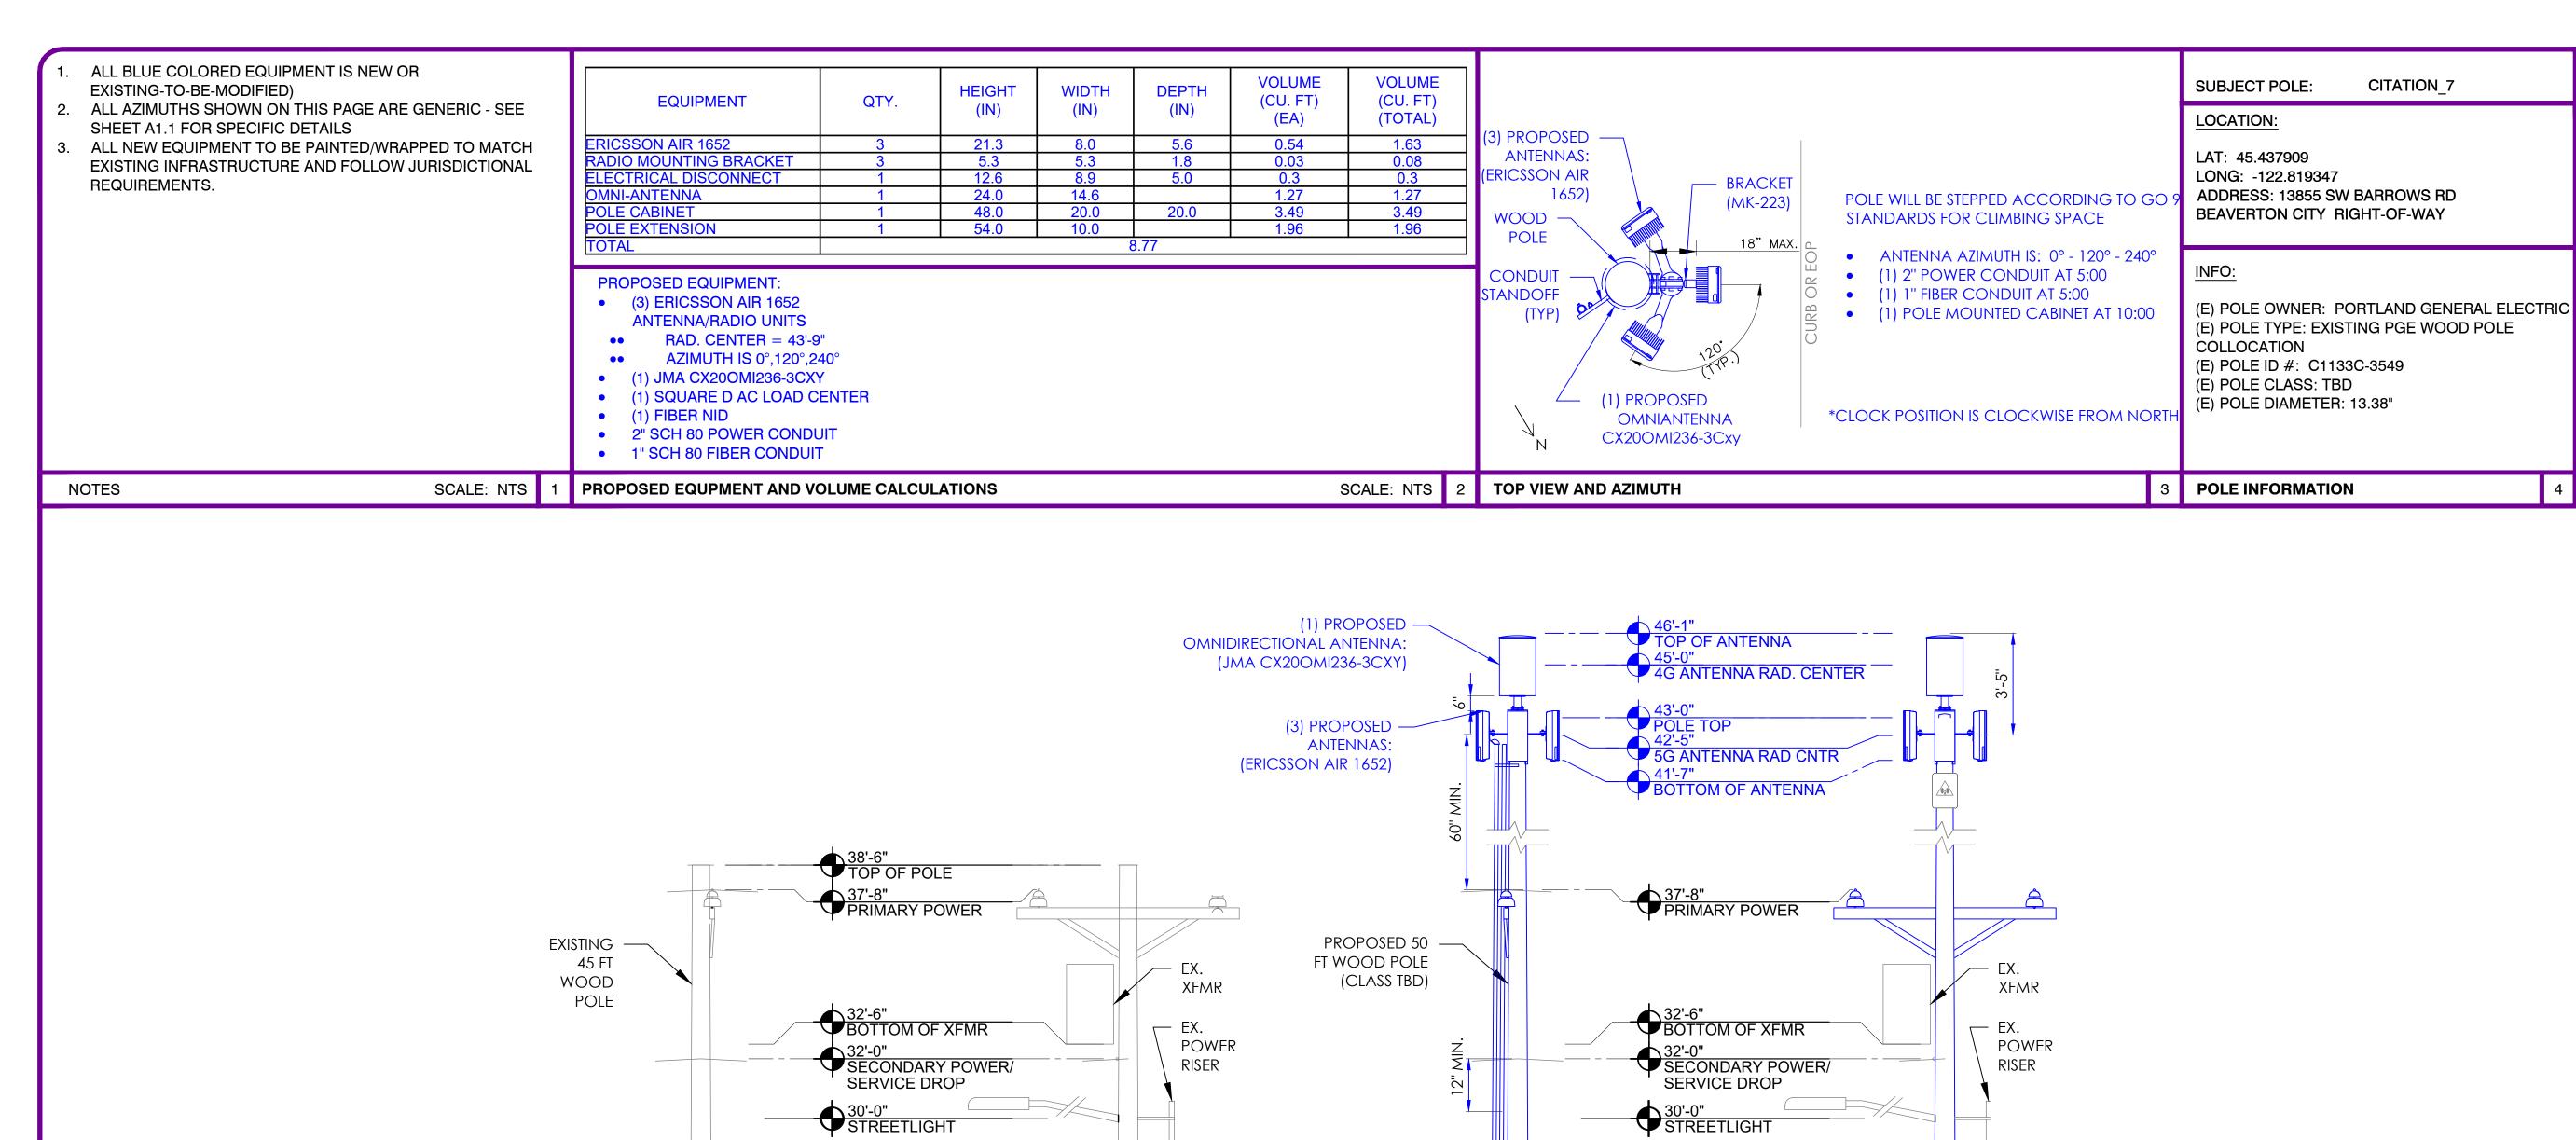

PROPOSED POLE — MOUNTED CABINET

RSCAC-1038-5Y7)

PROPOSED 5/8" X — 10' GROUND ROD

(RAYCAP

LOOKING SOUTH

NO CHANGES TO EXISTING
LUMINAIRE HEIGHT OR
ORIENTATION ARE PROPOSED.





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CANDIDATE:

CITATION_7

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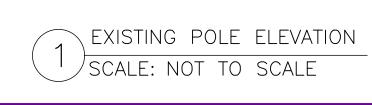
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POLE ELEVATION

SHEET NUMBER:

REVISION:




LOOKING EAST

27'-7"
CCI FIBER (FUTURE)

COMM. LINE

0'-0" GROUND

LOOKING SOUTH

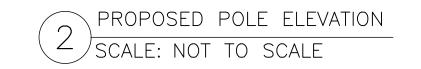

LOOKING EAST

INFO SIGN

27'-7"
CCI FIBER (FUTURE)
26'-7"
COMM. LINE

16'-0"
BOTTOM OF CABINET

(SQUARE D QO612L100RB)

25'-9" COMM. LINE

20'-0" TOP OF CAB.

100A SERVICE ENTRANCE RATED AC LOAD CENTER

17'-0" RF SIGN

0'-0" GROUND







6801 PORTWEST DR. SUITE 100 HOUSTON,TX 77024



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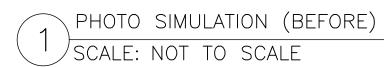
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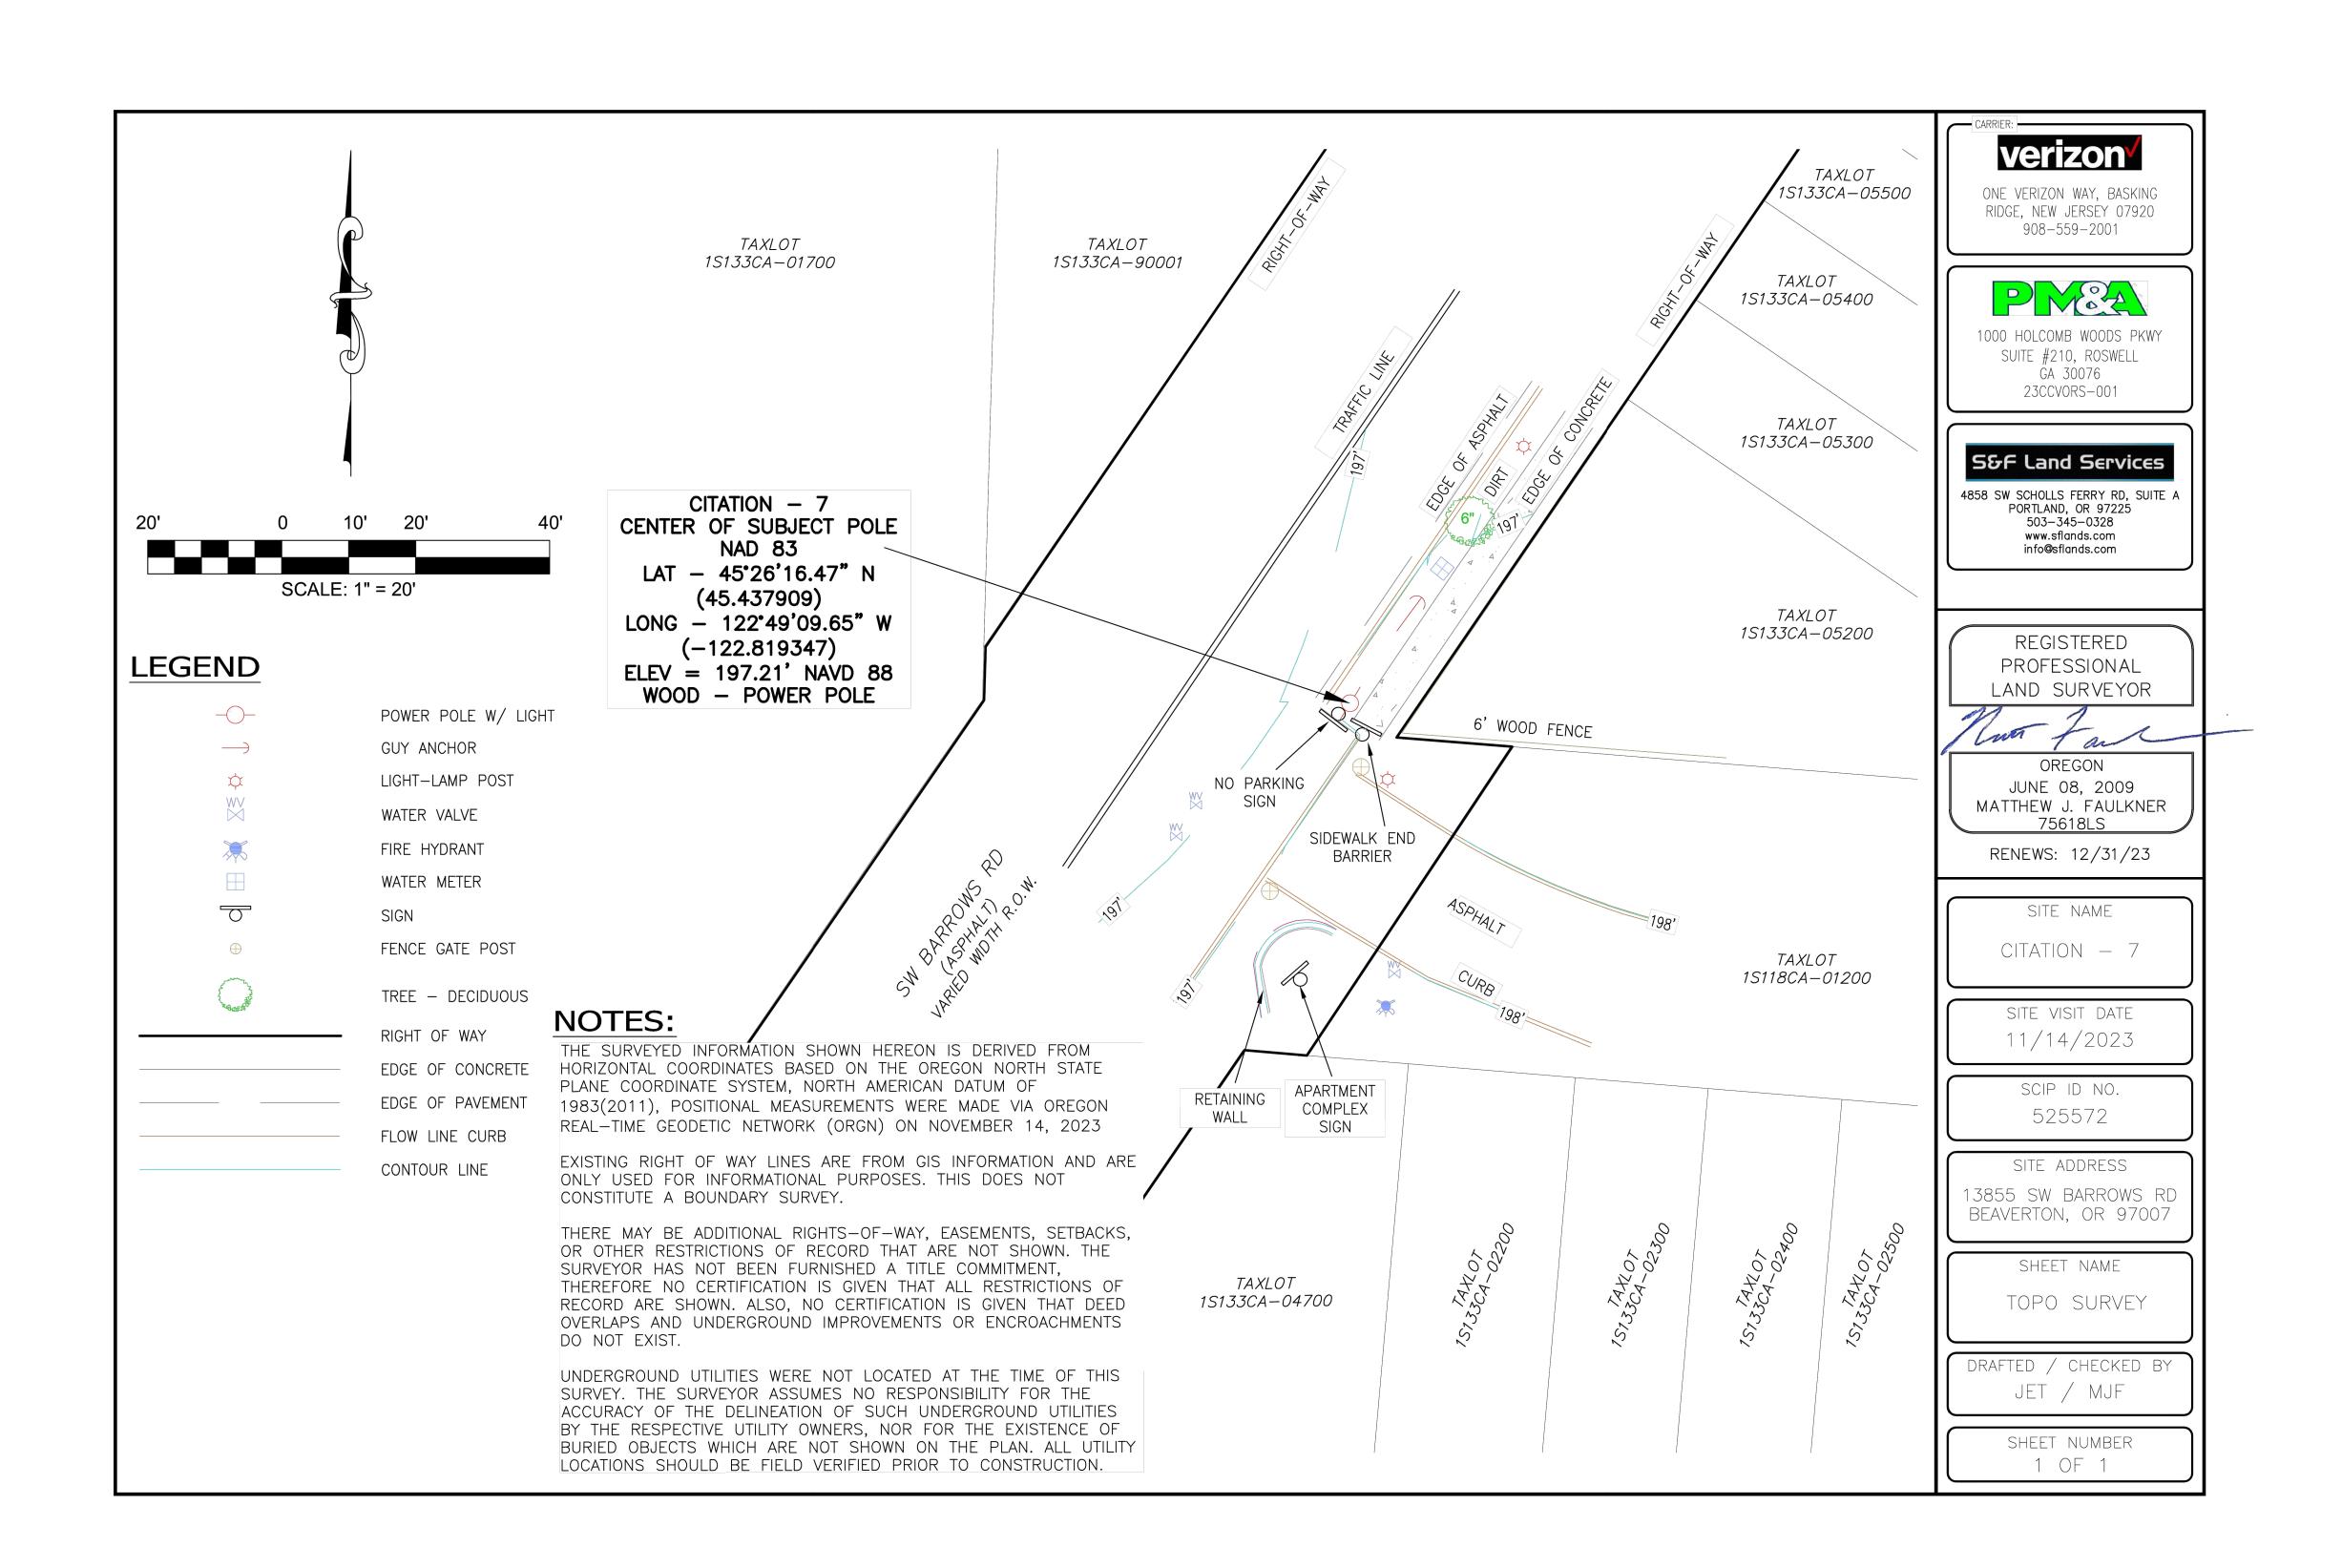
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PHOTO SIMULATION

SHEET NUMBER:







P. MARSHALL & ASSOCIATES

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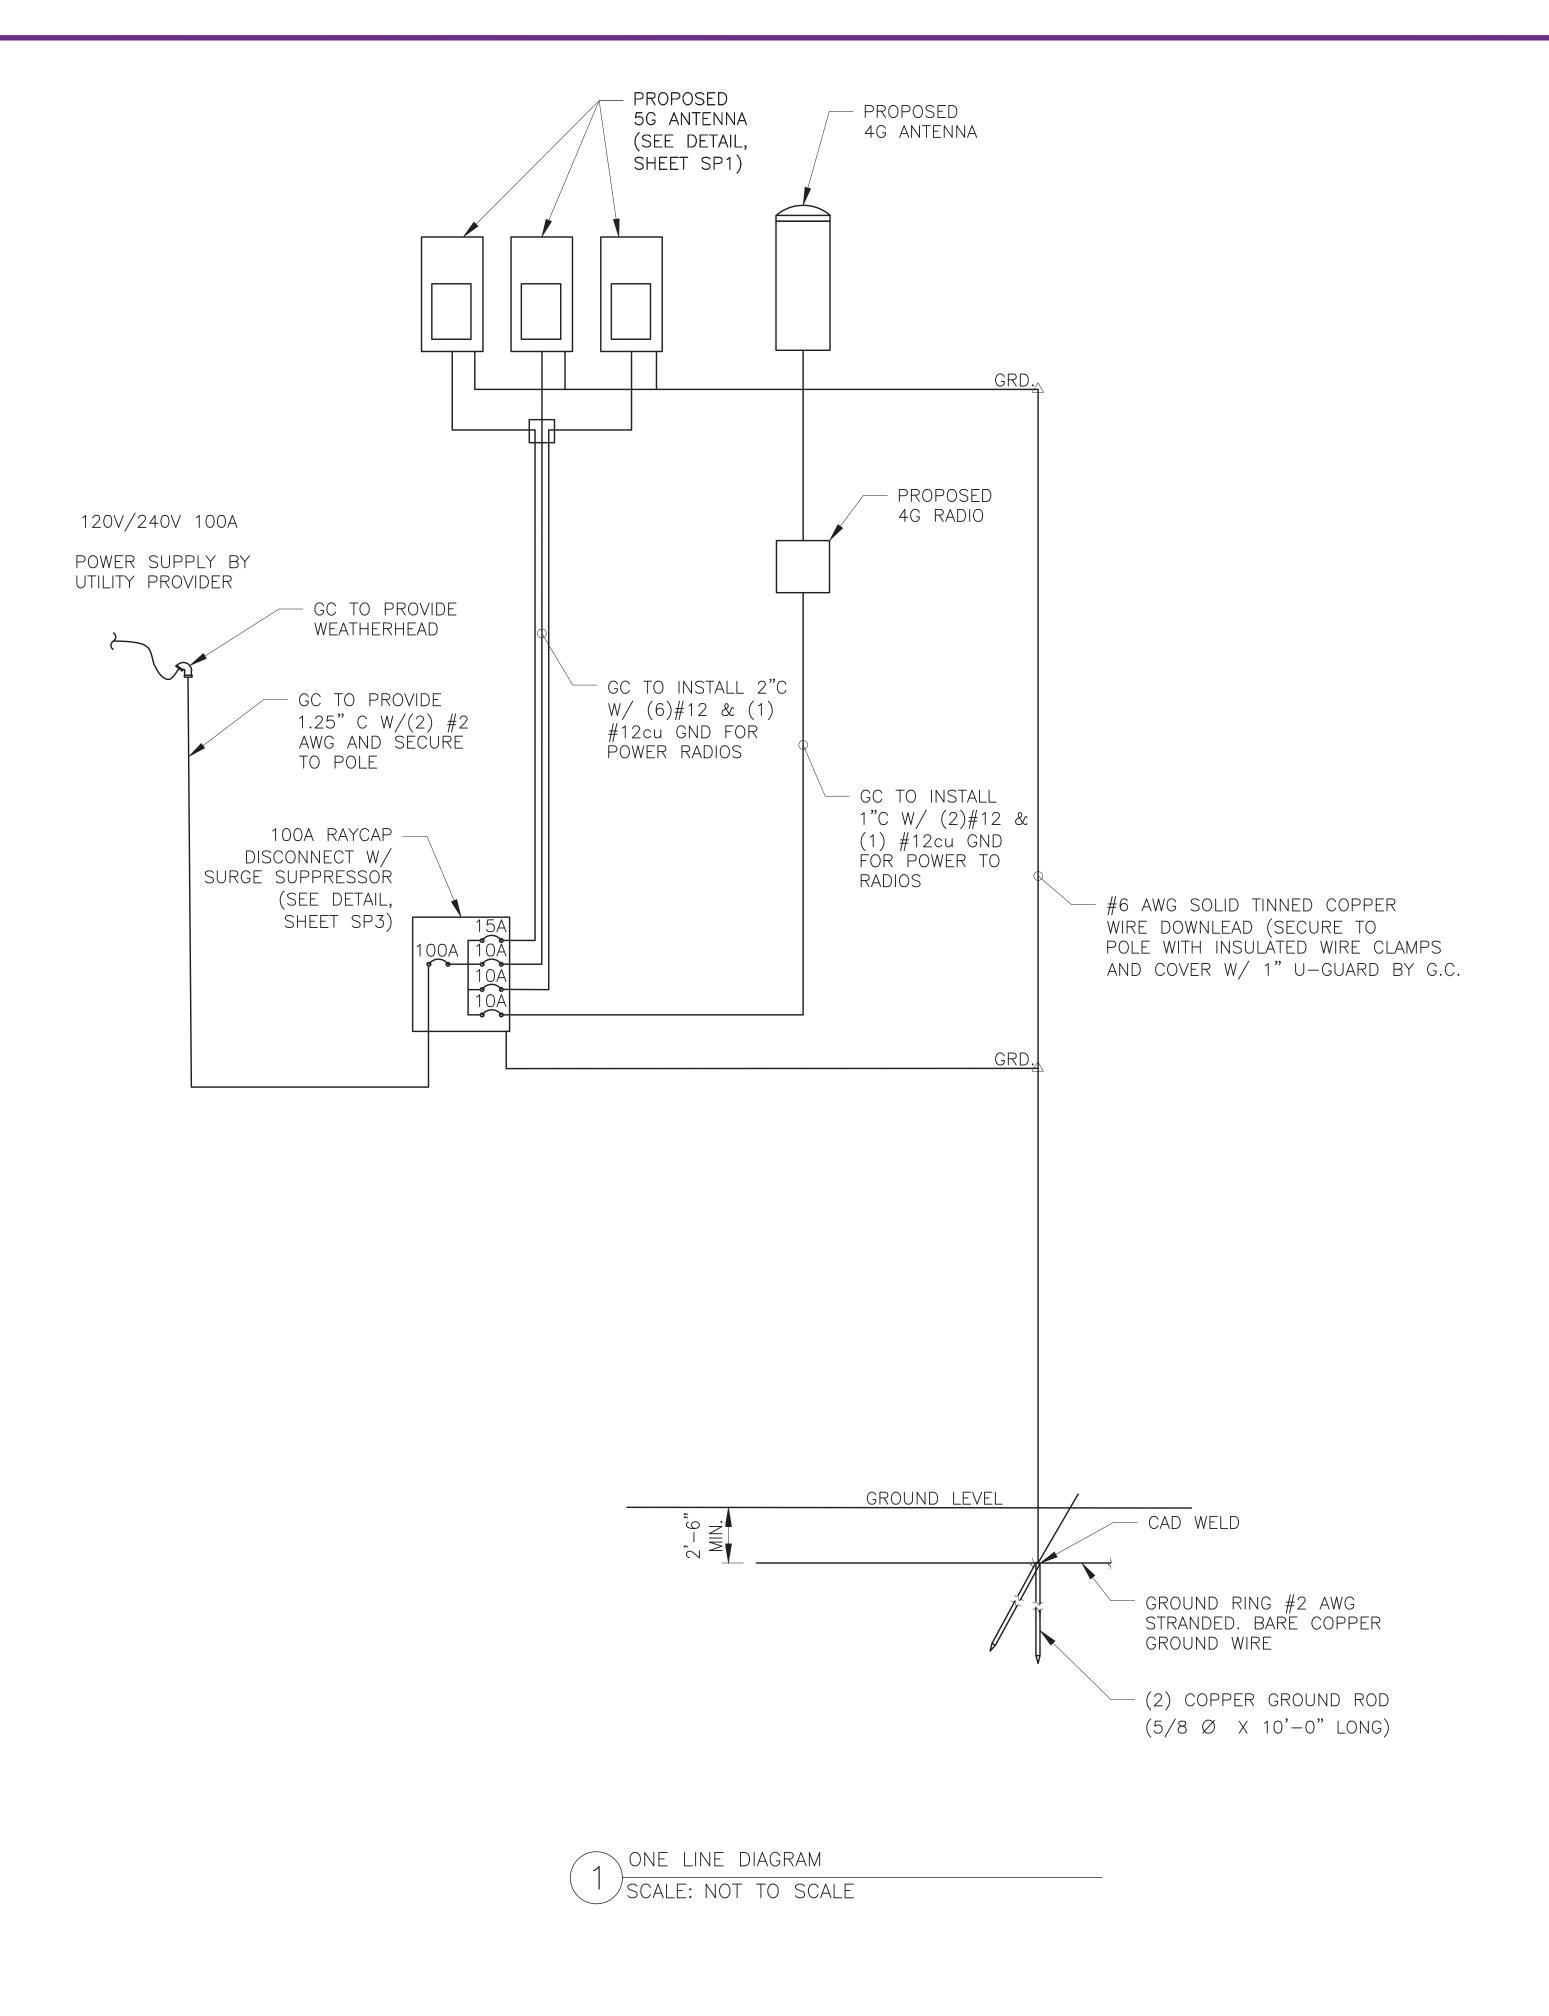
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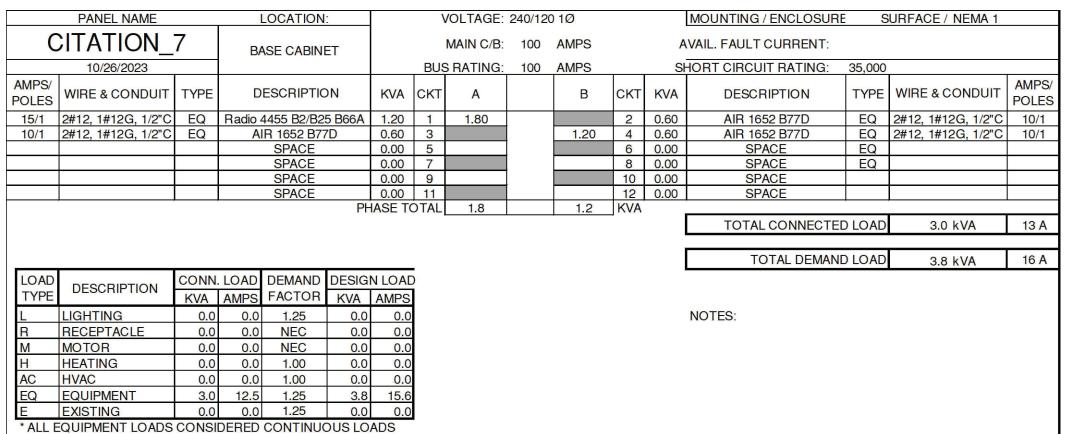
SITE SURVEY

SHEET NUMBER:

REVISION:


SURVEY
SCALE: NOT TO SCALE





PANEL SCHEDULE

SCALE: NOT TO SCALE

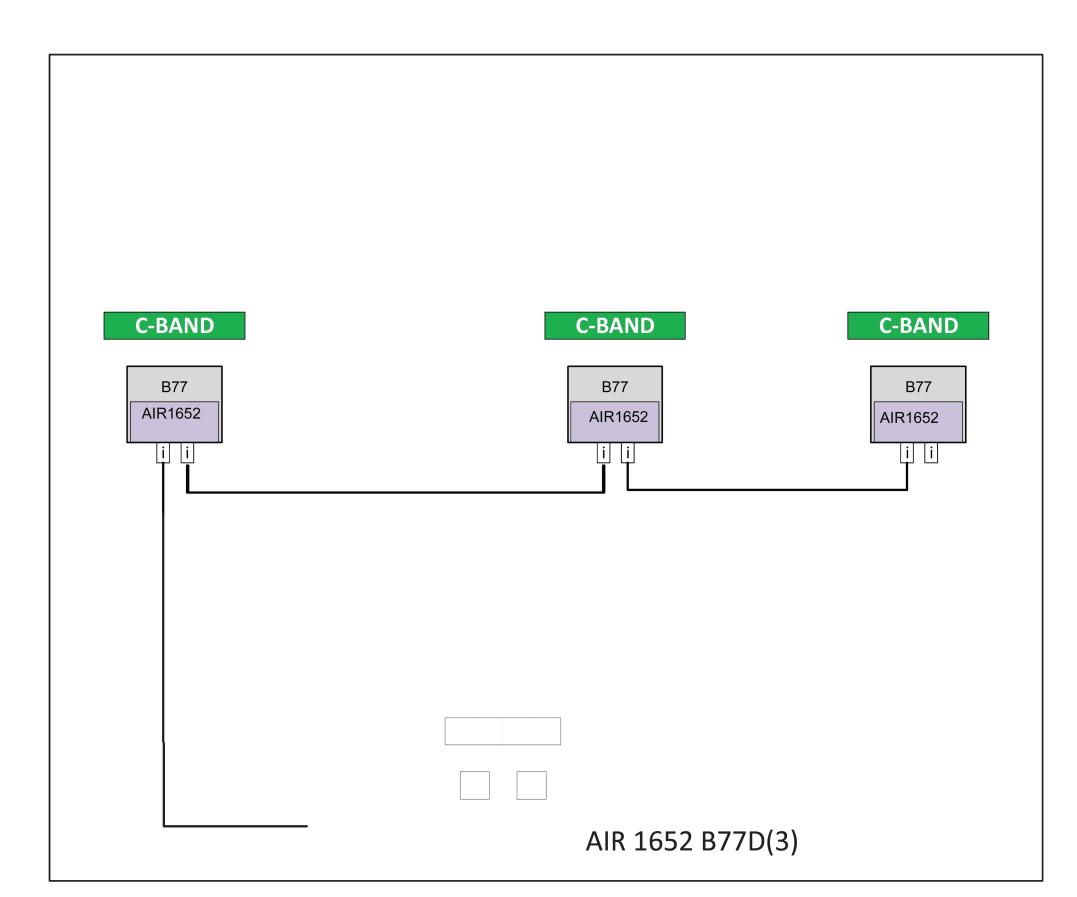







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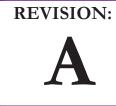
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SHEET TITLE:

ELECTRICAL DETAILS/ ONE LINE DIAGRAM

SHEET NUMBER:





3.3 Physical Characteristics

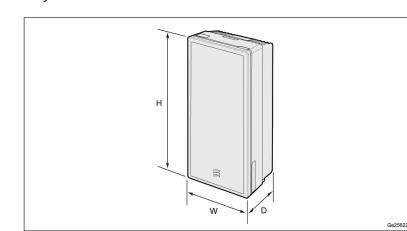


Figure 2 AIR Unit Dimensions

Table 6 AIR 1652 Dimensions

Product		Height, H (mm)	Width, W (mm)	Depth, D (mm)
AIR 1652 B77D	With protrusions	540	202	141
	Without protrusions	528	200	135

Table 7 AIR 1652 Weight

AIR Unit Type	Unit Weight ⁽¹⁾
AIR 1652 B77D	13.5 kg

Table 8 Mounting Kit Weight

Mounting Kit	Weight
SXK 109 2157/1	3.2 kg
SXK 109 2157/2	2.3 kg
SXK 109 2157/3	2.0 kg


332/1551-LZA 701 6001/1 Uen A | 2022-07-04

SCALE: NOT TO SCALE



- 1. ALL SIGNAGE TO BE MOUNTED TO POLE
- 2. ALL SIGNAGE SHOULD BE STAINLESS STEEL TO PREVENT CORROSION OVER TIME

WARNING AND INFORMATION SIGN SHOULD BE NO SMALLER THAN 6" X 7.5" WITJ MINIMUM READABLE LETTER HEIGHT AT 5FT. AWAY OF 0.20" FOR MESSAGE TEXT AND 0.44" FOR SIGNAL TEXT. SIGNS SHOWN ARE TYPICAL, ACTUAL SIGN MAY VARY PER VERIZON RF REQUIREMENTS FOR SITE. ALL SIGNS SHOULD FOLLOW THE VERIZON RADIO FREQUENCY COMPLIANCE SIGNAGE & DEMARCATION GUIDELINES DATED 3/3/20.

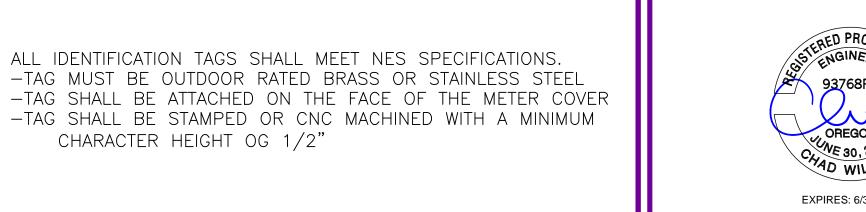



3" MIN, ADDRESS: 3855 SW BARROWS RD BEAVERTON, OR 97223

DIMENSIONS

MATERIAL

FINISH

Hot Rolled

WT. LBS.

DESCRIPTION


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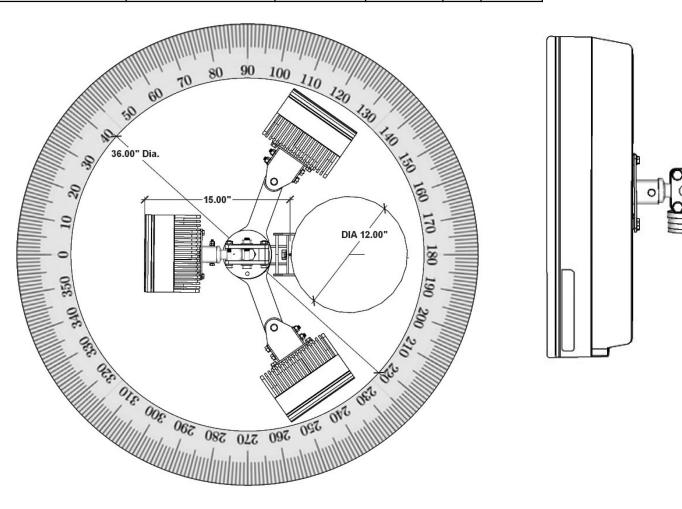
Side Arm Bracket


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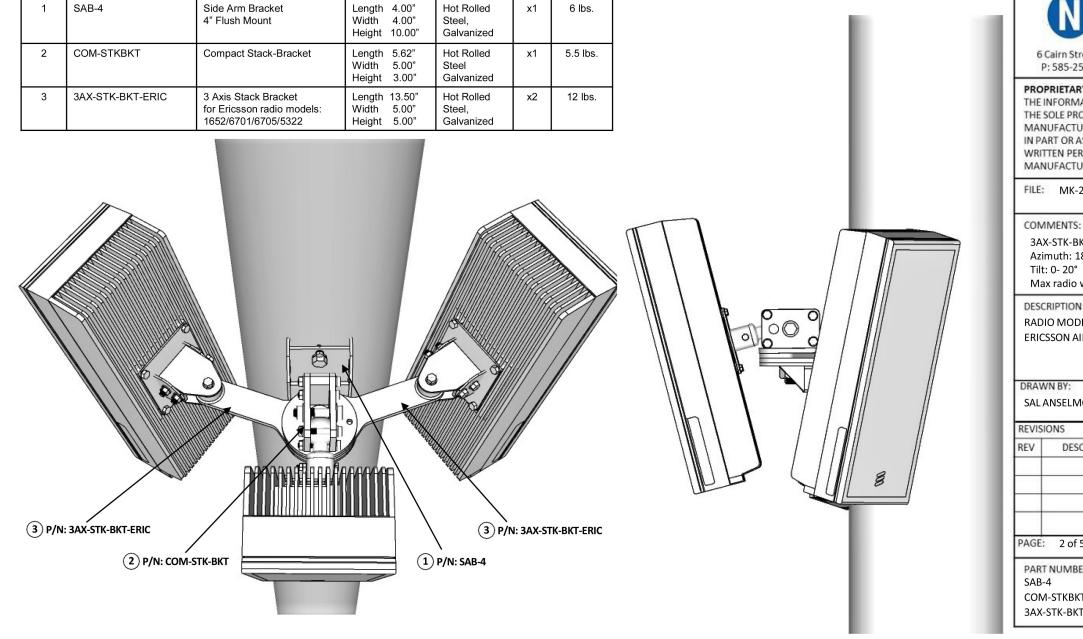
SIGNAGE NOTES ∠/SCALE: NOT TO SCALE








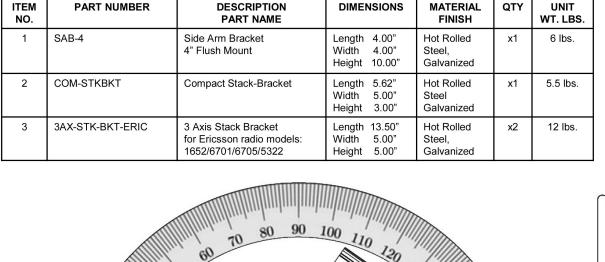

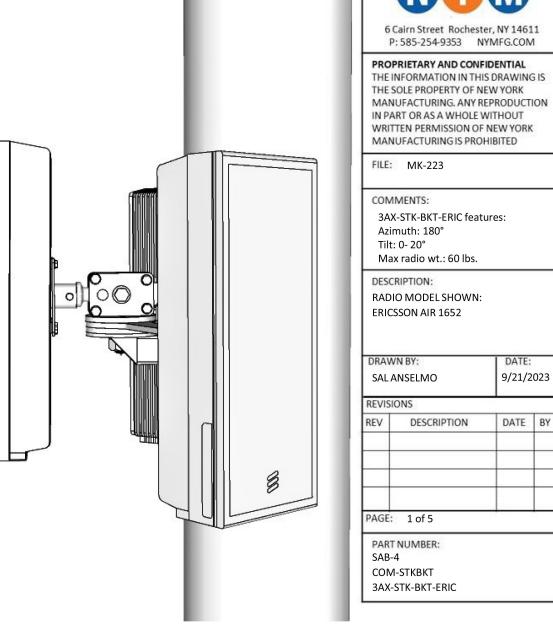

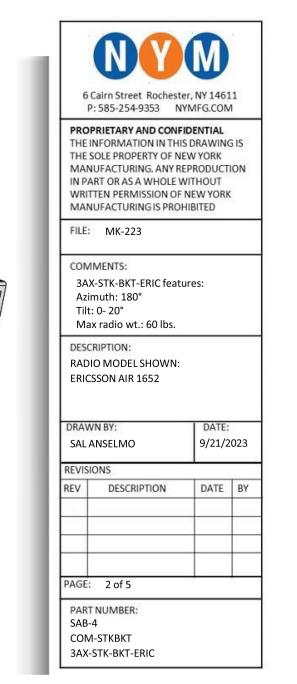







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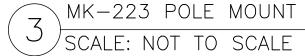
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ANTENNA & RRUS **SPECIFICATIONS**

SHEET TITLE:

REVISION:










DTC4 - 2 grommets per end



• Size: 10.8" x 7.8" x 3.2" (274 x 198 x 82 mm)



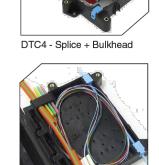

- DTC4 - IP-68 rated - Aerial, below grade, direct buried, pole – DTC6 - IP-68 rated Aerial, below grade, direct buried, pole mount or interior applications

DTC4 - Duct Transition

PLP® Fiber Optic Products

Identifying closure systems to protect the final connection point in your FTTH network is critical. Selecting one packed with features to support splicing, connectivity or ducting applications, using traditional cable, blown fiber, pushable drop cable technology or microtube cable, with a footprint slightly larger than a splice tray, has been impossible; until now. DTC6 - 3 grommets per end

COYOTE® DTC4/DTC6 (Drop Termination Closure)

The COYOTE DTC4 and DTC6 are the latest additions to the DTC (Drop Termination Closure) Family. Like the original DTC, these closures offer a durable, compact solution with multiple internal fiber organizers to support your current and future needs. Network evolution is unpredictable so why not choose a closure

Max Adapter Capacity: See table for adapter

• Grommet Quantity: 4 or 6 – See table for

Flexible grommet sealing system supports a wide range of flat or round cable profiles

Designed to GR-771 Generic Requirements for Fiber Splice Closures

Constructed with flame retardant UV stabilized

Factory installed sealing materials Reenterable and reusable

system developed to adapt.


Max Splice Capacity: 24

grommet options

Applications:





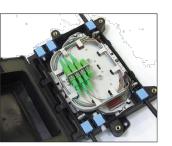


DTC6 - Splice + Bulkhead

COYOTE DTC4/DTC6 (JUNCTION BOX) SCALE: NOT TO SCALE


Product data sheet Characteristics

QO612L100RB LOAD Center QO MLO 240V 100A 1PH 6SP



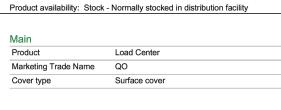

Complementary		
Load Center Type	Main lugs	
Line Rated Current	rent 100 A	
Number of spaces	6	
Short Circuit Current Rating	10 kA	
Maximum Number of Single Pole Circuits	12	
Maximum Number of Tandem Breakers	6	
Number of Phases	1 phase	
Voltage Rating	120/240 V AC	
Wire Size	AWG 8AWG 1 aluminium/copper	
Electrical Connection	Lugs	
Grounding Bar	Grounding bar (ordered separately)	
Electrical connection	Lugs	
Wiring configuration	3-wire	
Busbar Material	Tin plated aluminium busbar	
Enclosure Material	Welded galvannealed steel	
Cover Finish	Baked enamel grey	
Box number	2R	
Height	12.64 in (321 mm)	
Width	8.90 in (226 mm)	
Tightening torque	5.65 N.M (50 lbf.in) AWG 8) 5.65 N.m (50 lbf.in) AWG 6AWG 1/0)	
Environment		
Enclosure Rating	NEMA 3R outdoor	
Ambient air temperature for operation	23 °F (-5 °C) 104 °F (40 °C)	
Product certifications	UL listed	
Ordering and shipping details		
Category	00101 - QO 1PH LC,2-8CKT,NEMA 1,3R	
Discount Schedule	DE3A	
GTIN	00785901785590	
Package weight(Lbs)	4.38 kg (9.65 lb(US))	
Returnability	Yes	
Country of origin	MX	

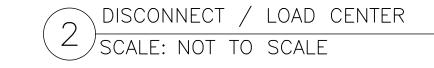





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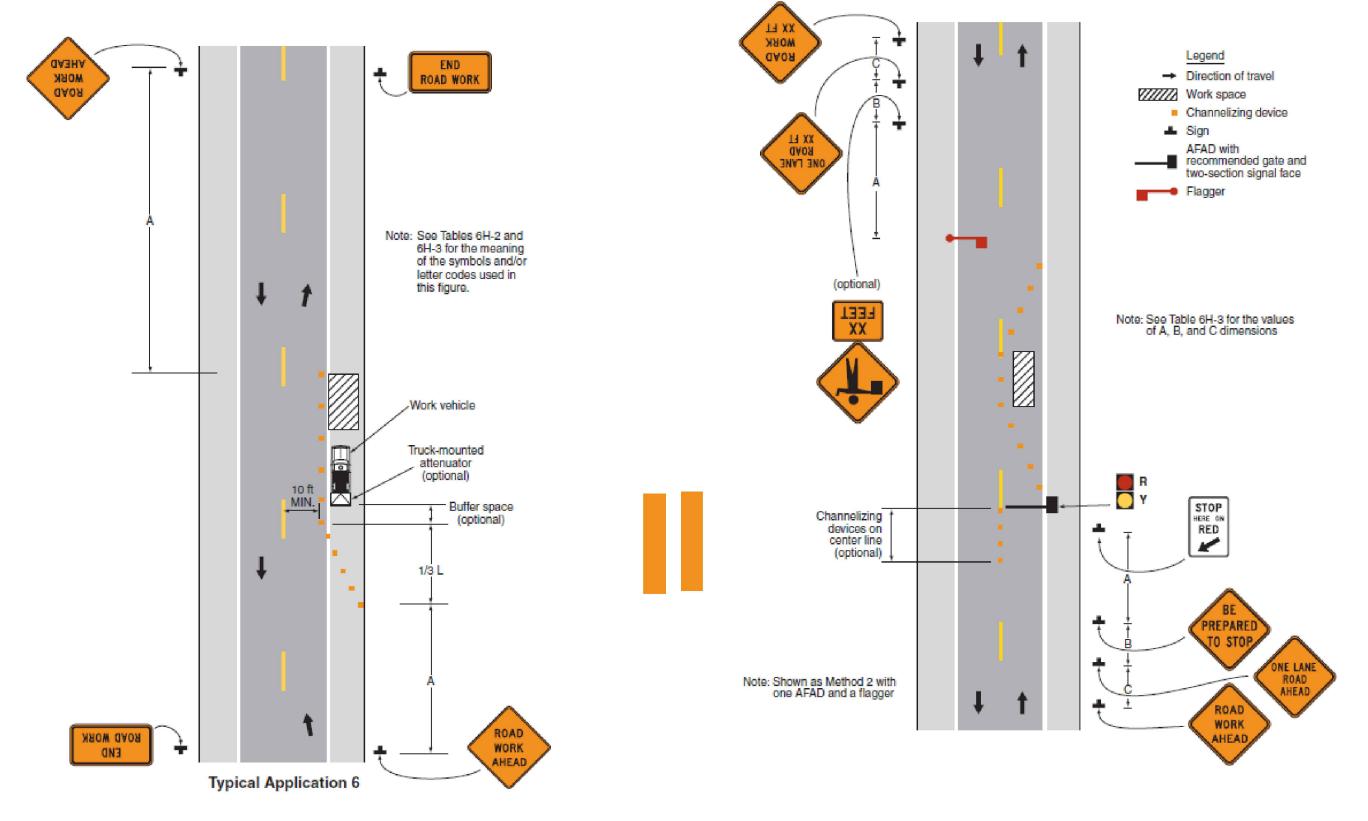
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EQUIPMENT **SPECIFICATIONS**

SHEET NUMBER:

REVISION:



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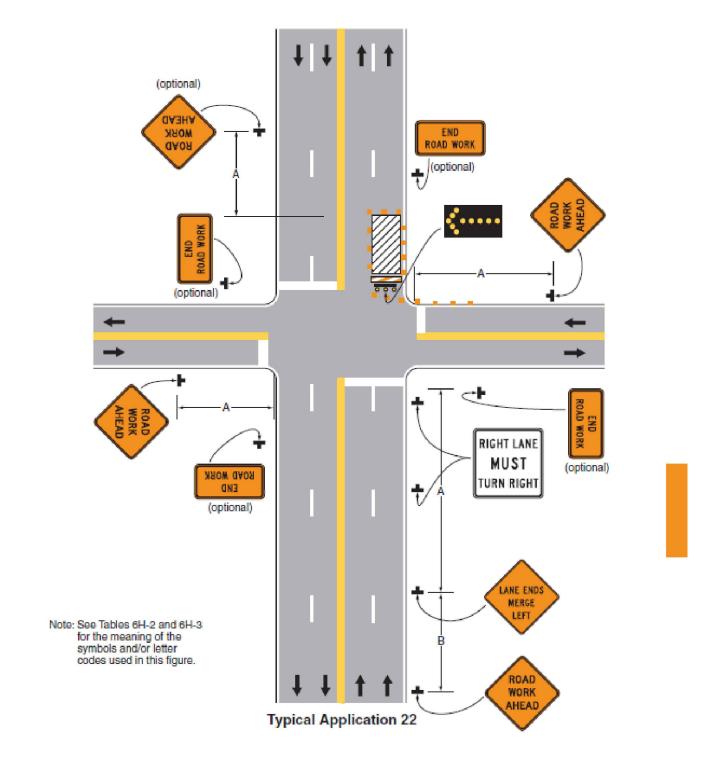
December 2009

Figure 6H-22. Right-Hand Lane Closure on the Far Side of an Intersection (TA-22)

Sect. 6H.01

Sect. 6E.06

Page 679



Sect. 6H.01

Table 6C-3. Taper Length Criteria for Temporary Traffic Control Zones

Type of Taper	Taper Length	
Merging Taper	at least L	
Shifting Taper	at least 0.5 L	
Shoulder Taper	at least 0.33 L	
One-Lane, Two-Way Traffic Taper	50 feet minimum, 100 feet maximum	
Downstream Taper	50 feet minimum, 100 feet maximum	

Note: Use Table 6C-4 to calculate L

Table 6C-4. Formulas for Determining Taper Length

Speed (S)	Taper Length (L) in feet
40 mph or less	$L = \frac{WS^2}{60}$
45 mph or more	L= WS

Where: L = taper length in feet

W = width of offset in feet

S = posted speed limit, or off-peak 85th-percentile speed prior to work starting, or the anticipated operating speed in mph

Table 6C-2. Stopping Sight Distance as a Function of Speed

Speed*	Distance	
20 mph	115 feet	
25 mph	155 feet	
30 mph	200 feet	
35 mph	250 feet	
40 mph	305 feet	
45 mph	360 feet	
50 mph	425 feet	
55 mph	495 feet	
60 mph	570 feet	
65 mph	645 feet	
70 mph	730 feet	
75 mph	820 feet	

^{*} Posted speed, off-peak 85th-percentile speed prior to work starting, or the anticipated operating speed

2009 Edition

Table 6C-1. Recommended Advance Warning Sign Minimum Spacing

Page 556

Dood Tymo	Distance Between Signs**		
Road Type	Α	В	С
Urban (low speed)*	100 feet	100 feet	100 feet
Urban (high speed)*	350 feet	350 feet	350 feet
Rural	500 feet	500 feet	500 feet
Expressway / Freeway	1,000 feet	1,500 feet	2,640 feet

 ^{*} Speed category to be determined by the highway agency
 ** The column headings A, B, and C are the dimensions shown in Figures 6H-1 through 6H-46.
 The A dimension is the distance from the transition or point of restriction to the first sign. The B dimension is the distance between the first and second signs. The C dimension is the distance between the second and third signs. (The "first sign" is the sign in a three-sign series that is closest to the TTC zone. The "third sign" is the sign that is furthest upstream from the TTC zone.)







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HUB: 167612

SHEET TITLE:

TRAFFIC CONTROL PLAN

SHEET NUMBER:



CROWN CASTLE USA INC. SITE ACTIVITY REQUIREMENTS:

- NOTICE TO PROCEED— NO WORK SHALL COMMENCE PRIOR TO CROWN CASTLE USA INC. WRITTEN NOTICE TO PROCEED (NTP) AND THE ISSUANCE OF A PURCHASE ORDER. PRIOR TO ACCESSING/ENTERING THE SITE YOU MUST CONTACT THE CROWN CASTLE USA INC. NOC AT 800-788-7011 & THE CROWN CASTLE USA INC. CONSTRUCTION MANAGER.
- PRIOR TO THE START OF CONSTRUCTION, ALL REQUIRED JURISDICTIONAL PERMITS SHALL BE OBTAINED. THIS INCLUDES, BUT IS NOT LIMITED TO, BUILDING, ELECTRICAL, MECHANICAL, FIRE, FLOOD ZONE, ENVIRONMENTAL, AND ZONING. AFTER ONSITE ACTIVITIES AND CONSTRUCTION ARE COMPLETED, ALL REQUIRED PERMITS SHALL BE SATISFIED AND CLOSED OUT ACCORDING TO LOCAL JURISDICTIONAL
- ALL CONSTRUCTION MEANS AND METHODS: INCLUDING BUT NOT LIMITED TO, ERECTION PLANS, RIGGING PLANS, CLIMBING PLANS, AND RESCUE PLANS SHALL BE THE RESPONSIBILITY OF THE GENERAL CONTRACTOR RESPONSIBLE FOR THE EXECUTION OF THE WORK CONTAINED HEREIN, AND SHALL MEET ANSI/ASSE A10.48 (LATEST EDITION); FEDERAL, STATE, AND LOCAL REGULATIONS; AND ANY APPLICABLE INDUSTRY CONSENSUS STANDARDS RELATED TO THE CONSTRUCTION ACTIVITIES BEING PERFORMED. ALL RIGGING PLANS SHALL ADHERE TO ANSI/ASSE A10.48 (LATEST EDITION) AND CROWN CASTLE USA INC. STANDARD CED-STD-10253, INCLUDING THE REQUIRED INVOLVEMENT OF A QUALIFIED ENGINEER FOR CLASS IV CONSTRUCTION, TO CERTIFY THE SUPPORTING STRUCTURE(S) IN ACCORDANCE WITH ANSI/TIA-322 (LATEST EDITION).
- ALL SITE WORK TO COMPLY WITH QAS-STD-10068 "INSTALLATION STANDARDS FOR CONSTRUCTION ACTIVITIES ON CROWN CASTLE USA INC. TOWER SITE," CED-STD-10294 "STANDARD FOR INSTALLATION OF MOUNTS AND APPURTENANCES," AND LATEST VERSION OF ANSI/TIA-1019-A-2012 "STANDARD FOR INSTALLATION, ALTERATION, AND MAINTENANCE OF ANTENNA SUPPORTING STRUCTURES AND ANTENNAS."
- IF THE SPECIFIED EQUIPMENT CAN NOT BE INSTALLED AS SHOWN ON THESE DRAWINGS, THE CONTRACTOR SHALL PROPOSE AN ALTERNATIVE INSTALLATION FOR APPROVAL BY CROWN CASTLE USA INC. PRIOR TO PROCEEDING WITH ANY SUCH CHANGE OF INSTALLATION.
- ALL MATERIALS FURNISHED AND INSTALLED SHALL BE IN STRICT ACCORDANCE WITH ALL APPLICABLE CODES, REGULATIONS AND ORDINANCES. CONTRACTOR SHALL ISSUE ALL APPROPRIATE NOTICES AND COMPLY WITH ALL LAWS, ORDINANCES, RULES, REGULATIONS AND LAWFUL ORDERS OF ANY PUBLIC AUTHORITY REGARDING THE PERFORMANCE OF THE WORK. ALL WORK CARRIED OUT SHALL COMPLY WITH ALL APPLICABLE MUNICIPAL AND UTILITY COMPANY SPECIFICATIONS AND LOCAL JURISDICTIONAL CODES. ORDINANCES AND APPLICABLE REGULATIONS.
- THE CONTRACTOR SHALL INSTALL ALL EQUIPMENT AND MATERIALS IN ACCORDANCE WITH MANUFACTURER'S RECOMMENDATIONS UNLESS SPECIFICALLY STATED OTHERWISE.
- THE CONTRACTOR SHALL CONTACT UTILITY LOCATING SERVICES PRIOR TO THE START OF CONSTRUCTION. ALL EXISTING ACTIVE SEWER, WATER, GAS, ELECTRIC AND OTHER UTILITIES WHERE ENCOUNTERED IN THE WORK, SHALL BE PROTECTED AT ALL TIMES AND WHERE REQUIRED FOR THE PROPER EXECUTION OF THE WORK, SHALL BE RELOCATED AS DIRECTED BY CONTRACTOR. EXTREME CAUTION SHOULD BE USED BY THE CONTRACTOR WHEN EXCAVATING OR DRILLING PIERS AROUND OR NEAR UTILITIES. CONTRACTOR SHALL PROVIDE SAFETY TRAINING FOR THE WORKING CREW. THIS WILL INCLUDE BUT NOT BE LIMITED TO A) FALL PROTECTION B) CONFINED SPACE C) ELECTRICAL SAFETY D) TRENCHING AND EXCAVATION E) CONSTRUCTION SAFETY PROCEDURES.
- 10. ALL SITE WORK SHALL BE AS INDICATED ON THE STAMPED CONSTRUCTION DRAWINGS AND PROJECT SPECIFICATIONS, LATEST APPROVED REVISION.
- 11. CONTRACTOR SHALL KEEP THE SITE FREE FROM ACCUMULATING WASTE MATERIAL, DEBRIS, AND TRASH AT THE COMPLETION OF THE WORK. IF NECESSARY, RUBBISH, STUMPS, DEBRIS, STICKS, STONES AND OTHER REFUSE SHALL BE REMOVED FROM THE SITE AND DISPOSED OF LEGALLY.
- 12. ALL EXISTING INACTIVE SEWER, WATER, GAS, ELECTRIC AND OTHER UTILITIES, WHICH INTERFERE WITH THE EXECUTION OF THE WORK, SHALL BE REMOVED AND/OR CAPPED, PLUGGED OR OTHERWISE DISCONTINUED AT POINTS WHICH WILL NOT INTERFERE WITH THE EXECUTION OF THE WORK, SUBJECT TO THE APPROVAL OF CONTRACTOR, TOWER OWNER, CROWN CASTLE USA INC., AND/OR LOCAL UTILITIES.
- 13. THE CONTRACTOR SHALL PROVIDE SITE SIGNAGE IN ACCORDANCE WITH THE TECHNICAL SPECIFICATION FOR SITE SIGNAGE REQUIRED BY LOCAL JURISDICTION AND SIGNAGE REQUIRED ON INDIVIDUAL PIECES OF EQUIPMENT, ROOMS, AND SHELTERS.
- 14. CONTRACTOR SHALL MINIMIZE DISTURBANCE TO EXISTING SITE DURING CONSTRUCTION. EROSION CONTROL MEASURES, IF REQUIRED DURING CONSTRUCTION, SHALL BE IN CONFORMANCE WITH THE LOCAL GUIDELINES FOR EROSION AND SEDIMENT CONTROL.
- 15. THE CONTRACTOR SHALL PROTECT EXISTING IMPROVEMENTS, PAVEMENTS, CURBS, LANDSCAPING AND STRUCTURES. ANY DAMAGED PART SHALL BE REPAIRED AT CONTRACTOR'S EXPENSE TO THE SATISFACTION OF OWNER.
- 16. CONTRACTOR SHALL LEGALLY AND PROPERLY DISPOSE OF ALL SCRAP MATERIALS SUCH AS COAXIAL CABLES AND OTHER ITEMS REMOVED FROM THE EXISTING FACILITY. ANTENNAS REMOVED SHALL BE RETURNED TO THE OWNER'S DESIGNATED LOCATION.
- 17. CONTRACTOR SHALL LEAVE PREMISES IN CLEAN CONDITION. TRASH AND DEBRIS SHOULD BE REMOVED FROM SITE ON A DAILY BASIS.
- 18. NO FILL OR EMBANKMENT MATERIAL SHALL BE PLACED ON FROZEN GROUND. FROZEN MATERIALS, SNOW OR ICE SHALL NOT BE PLACED IN ANY FILL OR EMBANKMENT.

general notes:

DESIGNATED LOCATION.

1. FOR THE PURPOSE OF CONSTRUCTION DRAWING, THE FOLLOWING DEFINITIONS SHALL APPLY: CONTRACTOR: GENERAL CONTRACTOR RESPONSIBLE FOR CONSTRUCTION CARRIER:

TOWER OWNER: CROWN CASTLE USA INC. THESE DRAWINGS HAVE BEEN PREPARED USING STANDARDS OF PROFESSIONAL CARE AND COMPLETENESS NORMALLY EXERCISED UNDER SIMILAR CIRCUMSTANCES BY REPUTABLE ENGINEERS IN THIS OR SIMILAR LOCALITIES. IT IS ASSUMED THAT THE WORK DEPICTED WILL BE PERFORMED BY AN EXPERIENCED CONTRACTOR AND/OR WORKPEOPLE

WHO HAVE A WORKING KNOWLEDGE OF THE APPLICABLE CODE STANDARDS AND REQUIREMENTS AND OF INDUSTRY ACCEPTED STANDARD GOOD PRACTICE. AS NOT EVERY CONDITION OR ELEMENT IS (OR CAN BE) EXPLICITLY SHOWN ON THESE DRAWINGS, THE CONTRACTOR SHALL USE INDUSTRY ACCEPTED STANDARD GOOD PRACTICE FOR MISCELLANEOUS WORK NOT EXPLICITLY SHOWN. THESE DRAWINGS REPRESENT THE FINISHED STRUCTURE. THEY DO NOT INDICATE THE MEANS OR METHODS OF CONSTRUCTION. THE CONTRACTOR SHALL BE SOLELY RESPONSIBLE FOR THE CONSTRUCTION MEANS, METHODS,

TECHNIQUES, SEQUENCES, AND PROCEDURES. THE CONTRACTOR SHALL PROVIDE ALL MEASURES NECESSARY FOR PROTECTION OF LIFE AND PROPERTY DURING CONSTRUCTION. SUCH MEASURES SHALL INCLUDE, BUT NOT BE LIMITED TO, BRACING, FORMWORK, SHORING, ETC. SITE VISITS BY THE ENGINEER OR HIS REPRESENTATIVE WILL NOT INCLUDE INSPECTION OF THESE ITEMS AND IS FOR STRUCTURAL OBSERVATION OF THE FINISHED STRUCTURE ONLY.

NOTES AND DETAILS IN THE CONSTRUCTION DRAWINGS SHALL TAKE PRECEDENCE OVER GENERAL NOTES AND TYPICAL DETAILS. WHERE NO DETAILS ARE SHOWN, CONSTRUCTION SHALL CONFORM TO SIMILAR WORK ON THE PROJECT, AND/OR AS PROVIDED FOR IN THE CONTRACT DOCUMENTS. WHERE DISCREPANCIES OCCUR BETWEEN PLANS, DETAILS, GENERAL NOTES, AND SPECIFICATIONS, THE GREATER, MORE STRICT REQUIREMENTS, SHALL GOVERN. IF FURTHER CLARIFICATION IS REQUIRED CONTACT THE ENGINEER OF RECORD.

SUBSTANTIAL EFFORT HAS BEEN MADE TO PROVIDE ACCURATE DIMENSIONS AND MEASUREMENTS ON THE DRAWINGS TO ASSIST IN THE FABRICATION AND/OR PLACEMENT OF CONSTRUCTION ELEMENTS BUT IT IS THE SOLE RESPONSIBILITY OF THE CONTRACTOR TO FIELD VERIFY THE DIMENSIONS, MEASUREMENTS, AND/OR CLEARANCES SHOWN IN THE CONSTRUCTION DRAWINGS PRIOR TO FABRICATION OR CUTTING OF ANY NEW OR EXISTING CONSTRUCTION ELEMENTS. IF IT IS DETERMINED THAT THERE ARE DISCREPANCIES AND/OR CONFLICTS WITH THE CONSTRUCTION DRAWINGS THE ENGINEER OF RECORD IS TO BE NOTIFIED AS SOON AS POSSIBLE.

PRIOR TO THE SUBMISSION OF BIDS, THE BIDDING CONTRACTOR SHALL VISIT THE CELL SITE TO FAMILIARIZE WITH THE EXISTING CONDITIONS AND TO CONFIRM THAT THE WORK CAN BE ACCOMPLISHED AS SHOWN ON THE CONSTRUCTION DRAWINGS. ANY DISCREPANCY FOUND SHALL BE BROUGHT TO THE ATTENTION OF CROWN CASTLE

ALL MATERIALS FURNISHED AND INSTALLED SHALL BE IN STRICT ACCORDANCE WITH ALL APPLICABLE CODES, REGULATIONS AND ORDINANCES. CONTRACTOR SHALL ISSUE ALL APPROPRIATE NOTICES AND COMPLY WITH ALL LAWS, ORDINANCES, RULES, REGULATIONS AND LAWFUL ORDERS OF ANY PUBLIC AUTHORITY REGARDING THE PERFORMANCE OF THE WORK. ALL WORK CARRIED OUT SHALL COMPLY WITH ALL APPLICABLE MUNICIPAL AND UTILITY COMPANY

SPECIFICATIONS AND LOCAL JURISDICTIONAL CODES, ORDINANCES AND APPLICABLE REGULATIONS. UNLESS NOTED OTHERWISE, THE WORK SHALL INCLUDE FURNISHING MATERIALS, EQUIPMENT, APPURTENANCES AND LABOR NECESSARY TO COMPLETE ALL INSTALLATIONS AS INDICATED ON THE DRAWINGS.

THE CONTRACTOR SHALL INSTALL ALL EQUIPMENT AND MATERIALS IN ACCORDANCE WITH MANUFACTURER'S RECOMMENDATIONS UNLESS SPECIFICALLY STATED OTHERWISE.

10. IF THE SPECIFIED EQUIPMENT CAN NOT BE INSTALLED AS SHOWN ON THESE DRAWINGS, THE CONTRACTOR SHALL PROPOSE AN ALTERNATIVE INSTALLATION FOR APPROVAL BY THE CARRIER AND CROWN CASTLE PRIOR TO PROCEEDING WITH ANY SUCH CHANGE OF INSTALLATION.

11. CONTRACTOR IS TO PERFORM A SITE INVESTIGATION AND IS TO DETERMINE THE BEST ROUTING OF ALL CONDUITS FOR POWER, AND TELCO AND FOR GROUNDING CABLES AS SHOWN IN THE POWER, TELCO, AND GROUNDING PLAN DRAWINGS

12. THE CONTRACTOR SHALL PROTECT EXISTING IMPROVEMENTS, PAVEMENTS, CURBS, LANDSCAPING AND STRUCTURES. ANY DAMAGED PART SHALL BE REPAIRED AT CONTRACTOR'S EXPENSE TO THE SATISFACTION OF CROWN CASTLE USA INC.

13. CONTRACTOR SHALL LEGALLY AND PROPERLY DISPOSE OF ALL SCRAP MATERIALS SUCH AS COAXIAL CABLES AND OTHER ITEMS REMOVED FROM THE EXISTING FACILITY. ANTENNAS REMOVED SHALL BE RETURNED TO THE OWNER'S

14. CONTRACTOR SHALL LEAVE PREMISES IN CLEAN CONDITION. TRASH AND DEBRIS SHOULD BE REMOVED FROM SITE ON A DAILY BASIS.

ELECTRICAL INSTALLATION NOTES:

- ALL ELECTRICAL WORK SHALL BE PERFORMED IN ACCORDANCE WITH THE PROJECT SPECIFICATIONS, NEC AND ALL APPLICABLE
- FEDERAL, STATE, AND LOCAL CODES/ORDINANCES. CONDUIT ROUTINGS ARE SCHEMATIC. CONTRACTOR SHALL INSTALL CONDUITS SO THAT ACCESS TO EQUIPMENT IS NOT BLOCKED AND TRIP HAZARDS ARE ELIMINATED.
- WIRING, RACEWAY AND SUPPORT METHODS AND MATERIALS SHALL COMPLY WITH THE REQUIREMENTS OF THE NEC.
- ALL CIRCUITS SHALL BE SEGREGATED AND MAINTAIN MINIMUM CABLE SEPARATION AS REQUIRED BY THE NEC. 4.1. ALL EQUIPMENT SHALL BEAR THE UNDERWRITERS LABORATORIES LABEL OF APPROVAL, AND SHALL CONFORM TO
- REQUIREMENT OF THE NATIONAL ELECTRICAL CODE. 4.2. ALL OVERCURRENT DEVICES SHALL HAVE AN INTERRUPTING CURRENT RATING THAT SHALL BE GREATER THAN THE SHORT CIRCUIT CURRENT TO WHICH THEY ARE SUBJECTED, 22,000 AIC MINIMUM. VERYIFY AVAILABLE SHORT CIRCUIT CURRENT DOES NOT EXCEED THE RATING OF ELECTRICAL EQUIPMENT IN ACCORDANCE WITH ARTICLE 110.24 NEC OR THE MOST CURRENT
- ADOPTED CODE PRE THE GOVERNING JURISDICTION. EACH END OF EVERY POWER PHASE CONDUCTOR, GROUNDING CONDUCTOR, AND TELCO CONDUCTOR OR CABLE SHALL BE LABELED WITH COLOR-CODED INSULATION OR ELECTRICAL TAPE (3M BRAND, 1/2" PLASTIC ELECTRICAL TAPE WITH UV
- PROTECTION, OR EQUAL). THE IDENTIFICATION METHOD SHALL CONFORM WITH NEC AND OSHA. ALL ELECTRICAL COMPONENTS SHALL BE CLEARLY LABELED WITH LAMICOID TAGS SHOWING THEIR RATED VOLTAGE, PHASE CONFIGURATION, WIRE CONFIGURATION, POWER OR AMPACITY RATING AND BRANCH CIRCUIT ID NUMBERS (i.e. PANEL BOARD AND
- CIRCUIT ID'S). PANEL BOARDS (ID NUMBERS) SHALL BE CLEARLY LABELED WITH PLASTIC LABELS.
- ALL TIE WRAPS SHALL BE CUT FLUSH WITH APPROVED CUTTING TOOL TO REMOVE SHARP EDGES. ALL POWER AND EQUIPMENT GROUND WIRING IN TUBING OR CONDUIT SHALL BE SINGLE COPPER CONDUCTOR (#14 OR LARGER)
- WITH TYPE THHW, THWN, THWN-2, XHHW, XHHW-2, THW, THW-2, RHW, OR RHW-2 INSULATION UNLESS OTHERWISE SPECIFIED. 10. SUPPLEMENTAL EQUIPMENT GROUND WIRING LOCATED INDOORS SHALL BE SINGLE COPPER CONDUCTOR (#6 OR LARGER) WITH
- TYPE THHW, THWN, THWN-2, XHHW, XHHW-2, THW, THW-2, RHW, OR RHW-2 INSULATION UNLESS OTHERWISE SPECIFIED. 11. POWER AND CONTROL WIRING IN FLEXIBLE CORD SHALL BE MULTI—CONDUCTOR, TYPE SOOW CORD (#14 OR LARGER) UNLESS
- OTHERWISE SPECIFIED. 12. POWER AND CONTROL WIRING FOR USE IN CABLE TRAY SHALL BE MULTI-CONDUCTOR, TYPE TC CABLE (#14 OR LARGER), WITH
- TYPE THHW, THWN, THWN-2, XHHW, XHHW-2, THW, THW-2, RHW, OR RHW-2 INSULATION UNLESS OTHERWISE SPECIFIED. 13. ALL POWER AND GROUNDING CONNECTIONS SHALL BE CRIMP-STYLE, COMPRESSION WIRE LUGS AND WIRE NUTS BY THOMAS AND BETTS (OR EQUAL). LUGS AND WIRE NUTS SHALL BE RATED FOR OPERATION NOT LESS THAN 75° C (90° C IF AVAILABLE).
- 14. RACEWAY AND CABLE TRAY SHALL BE LISTED OR LABELED FOR ELECTRICAL USE IN ACCORDANCE WITH NEMA, UL, ANSI/IEEE AND NEC.
- 15. ELECTRICAL METALLIC TUBING (EMT), INTERMEDIATE METAL CONDUIT (IMC), OR RIGID METAL CONDUIT (RMC) SHALL BE USED FOR EXPOSED INDOOR LOCATIONS.
- 16. ELECTRICAL METALLIC TUBING (EMT) OR METAL—CLAD CABLE (MC) SHALL BE USED FOR CONCEALED INDOOR LOCATIONS. 17. UNDERGROUND CONDUIT SHALL BE SCHEDULE 40 PVC ON STRAIGHTS AND SCHEDULE 80 PVC UNDER ALL TRAFFIC EASEMENTS AND ALL ELBOWS/90s. ABOVE GRADE CONDUIT TO BE SCH 80 PVC OR IMC/RMC CONDUIT. EMT IS ALLOWED AT STUB UP LOCATIONS AND INDOORS ONLY.
- 18. LIQUID—TIGHT FLEXIBLE METALLIC CONDUIT (LIQUID—TITE FLEX) SHALL BE USED INDOORS AND OUTDOORS, WHERE VIBRATION OCCURS OR FLEXIBILITY IS NEEDED.
- 19. CONDUIT AND TUBING FITTINGS SHALL BE THREADED OR COMPRESSION-TYPE AND APPROVED FOR THE LOCATION USED. SET SCREW FITTINGS ARE NOT ACCEPTABLE.
- 20. CABINETS, BOXES AND WIRE WAYS SHALL BE LABELED FOR ELECTRICAL USE IN ACCORDANCE WITH NEMA, UL, ANSI/IEEE AND
- 21. WIREWAYS SHALL BE METAL WITH AN ENAMEL FINISH AND INCLUDE A HINGED COVER, DESIGNED TO SWING OPEN DOWNWARDS
- (WIREMOLD SPECMATE WIREWAY). 22. SLOTTED WIRING DUCT SHALL BE PVC AND INCLUDE COVER (PANDUIT TYPE E OR EQUAL).
- 23. CONDUITS SHALL BE FASTENED SECURELY IN PLACE WITH APPROVED NON-PERFORATED STRAPS AND HANGERS. EXPLOSIVE DEVICES (i.e. POWDER-ACTUATED) FOR ATTACHING HANGERS TO STRUCTURE WILL NOT BE PERMITTED. CLOSELY FOLLOW THE LINES OF THE STRUCTURE, MAINTAIN CLOSE PROXIMITY TO THE STRUCTURE AND KEEP CONDUITS IN TIGHT ENVELOPES. CHANGES IN DIRECTION TO ROUTE AROUND OBSTACLES SHALL BE MADE WITH CONDUIT OUTLET BODIES. CONDUIT SHALL BE INSTALLED IN A NEAT AND WORKMANLIKE MANNER. PARALLEL AND PERPENDICULAR TO STRUCTURE WALL AND CEILING LINES. ALL CONDUIT SHALL BE FISHED TO CLEAR OBSTRUCTIONS. ENDS OF CONDUITS SHALL BE TEMPORARILY CAPPED FLUSH TO FINISH GRADE TO PREVENT CONCRETE, PLASTER OR DIRT FROM ENTERING. CONDUITS SHALL BE RIGIDLY CLAMPED TO BOXES BY GALVANIZED MALLEABLE IRON BUSHING ON INSIDE AND GALVANIZED MALLEABLE IRON LOCKNUT ON OUTSIDE AND INSIDE.
- 24. EQUIPMENT CABINETS, TERMINAL BOXES, JUNCTION BOXES AND PULL BOXES SHALL BE GALVANIZED OR EPOXY—COATED SHEET STEEL. SHALL MEET OR EXCEED UL 50 AND BE RATED NEMA 1 (OR BETTER) FOR INTERIOR LOCATIONS AND NEMA 3R (OR BETTER) FOR EXTERIOR LOCATIONS.
- 25. METAL RECEPTACLE, SWITCH AND DEVICE BOXES SHALL BE GALVANIZED, EPOXY—COATED OR NON—CORRODING; SHALL MEET OR EXCEED UL 514A AND NEMA OS 1 AND BE RATED NEMA 1 (OR BETTER) FOR INTERIOR LOCATIONS AND WEATHER PROTECTED (WP OR BETTER) FOR EXTERIOR LOCATIONS.
- 26. NONMETALLIC RECEPTACLE, SWITCH AND DEVICE BOXES SHALL MEET OR EXCEED NEMA OS 2 (NEWEST REVISION) AND BE RATED
- NEMA 1 (OR BETTER) FOR INTERIOR LOCATIONS AND WEATHER PROTECTED (WP OR BETTER) FOR EXTERIOR LOCATIONS. 27. THE CONTRACTOR SHALL NOTIFY AND OBTAIN NECESSARY AUTHORIZATION FROM THE CARRIER AND/OR CROWN CASTLE USA INC.
- BEFORE COMMENCING WORK ON THE AC POWER DISTRIBUTION PANELS. 28. THE CONTRACTOR SHALL PROVIDE NECESSARY TAGGING ON THE BREAKERS, CABLES AND DISTRIBUTION PANELS IN ACCORDANCE

APWA UNIFORM COLOR CODE:

EMPORARY SURVEY MARKINGS

LECTRIC POWER LINES, CABLES, CONDUIT, AND LIGHTING CABLES

GAS, OIL, STEAM, PETROLEUM, OR

COMMUNICATION, ALARM OR SIGNAL LINES, CABLES, OR CONDUIT AND TRAFFIC LOOPS

ECLAIMED WATER, IRRIGATION, AND

WHITE PROPOSED EXCAVATION

YELLOW GASEOUS MATERIALS

OTABLE WATER

LURRY LINES

SEWERS AND DRAIN LINES

- WITH THE APPLICABLE CODES AND STANDARDS TO SAFEGUARD LIFE AND PROPERTY.
- 29. ALL EMPTY/SPARE CONDUITS THAT ARE INSTALLED ARE TO HAVE A METERED MULE TAPE PULL CORD INSTALLED.

CONDUCTOR COLOR CODE			
SYSTEM	CONDUCTOR	COLOR	
	A PHASE	BLACK	
120/240V, 1Ø	B PHASE	RED	
120/2400, 10	NEUTRAL	WHITE	
	GROUND	GREEN	
	A PHASE	BLACK	
120/208V, 3Ø	B PHASE	RED	
	C PHASE	BLUE	
	NEUTRAL	WHITE	
	GROUND	GREEN	
	A PHASE	BROWN	
	B PHASE	ORANGE OR PURPLE	
277/480V, 3Ø	C PHASE	YELLOW	
	NEUTRAL	GREY	
	GROUND	GREEN	
DC VOLTAGE	POS (+)	RED**	
DC VOLIAGE	NEG (-)	BLACK**	

* SEE NEC 210.5(C)(1) AND (2) ** POLARITY MARKED AT TERMINATION

ABBREVIATIONS:

ANTENNA EXISTING

FACILITY INTERFACE FRAME GENERATOR

GLOBAL POSITIONING SYSTEM GLOBAL SYSTEM FOR MOBILE GSM LONG TERM EVOLUTION

MGB MASTER GROUND BAR MICROWAVE MW

NATIONAL ELECTRIC CODE PROPOSED POWER PLANT QTY QUANTITY

RFDS

RECT RECTIFIER RBS RADIO BASE STATION RET REMOTE ELECTRIC TILT

REMOTE RADIO HEAD RRH RRU REMOTE RADIO UNIT SIAD SMART INTEGRATED DEVICE TOWER MOUNTED AMPLIFIER

TYP TYPICAL UMTS UNIVERSAL MOBILE TELECOMMUNICATIONS SYSTEM WORK POINT

RADIO FREQUENCY DATA SHEET

6801 PORTWEST DR. SUITE 100 HOUSTON,TX 77024



IT IS A VIOLATION OF LAW FOR ANY PERSON, UNLESS THEY ARE ACTING UNDER THE DIRECTION OF A LICENSED PROFESSIONAL ENGINEER, TO ALTER THIS DOCUMENT.

REVISION				
REV	DATE	DRWN	DESCRIPTION	DES./QA
A	10/11/2023	MAG	PRELIMINARY	DC
В	01/10/2024	TD	PRELIMINARY	DC
С	02/13/2024	MAG	PRELIMINARY	DC
D	02/29/2024	TD	PRELIMINARY	DC
E	06/11/2024	MAG	LOWERED 5G ANT.	



CALL OREGON ONE CALL (800) 332-2344 CALL 3 WORKING DAYS BEFORE YOU DIG!



CANDIDATE:

13855 SW BARROWS RD BEAVERTON, OR 97223

> HUB: 167612

SHEET TITLE:

GENERAL NOTES

SHEET NUMBER:

REVISION: